

- This drawing has been prepared revising the Maximum Flood Level to +103.000.
- 2. For the details of weir & apron, bridge deck, sheet piles, gabion boxes and for the concrete mixes, sheet no. 1 /4 of Drawing no. 09 / 2014 of IDRB shall be followed.
- 3. Hydraulic Particulars:
- a. Maximum Flood Discharge 2243.00 m³/s b. Width of river
- 76.00 m - +103.000 c. High Flood Level
- d. Average Bed Level - +93.000
- Height of Shutter - 5.60m Crest Level - +93.400
- g. Full Reservoir Level - +99.000 Operating Platform Level - +111.100
- +106.211 Road Level
- 4. The groove size provided is 500 x 400 mm. "C" groove may be provided upto +105.500 and thereafter "L" groove may be provided.
- 5. For the reinforcement details of Dirt Wall and Abutment Cap sheet no. 4/4 of Drawing No. 09/ 2014 of IDRB shall be followed.
- 6. The piles shall be embedded into rock for a length of 1.20m (one pile dia) into hard rock and socketed.
- 7. Initial pile load test should be conducted as per IS 2911-Part IV for the maximum pile load before execution.

					76000					
+112.00 +111.00									 	+111.100 OPERATING PLATFORM
+112.00 +111.00 +110.00 +108.00 +107.00 +106.00 +105.00 +104.00 +102.00 +101.00 +10	E									+106.211 ROAD LEVEL
+104.00 +103.00					MFL +103.000)				1
+102.00 +101.00 +100.00 +99.00		6000 A1		000_ P2	Р3	P4		P5	A2 •	GROUND LEVEL
+98.00	0									
+94.00 — +93.00 —		V 7	0			•	•			+93.40 CREST LEVEL
+92.00	HIIIII		th total	181 111			1			+93.00 BED LEVEL
+88.00 +87.00 +86.00				L	++-	-	•			ROCK LEVEL
+85.00 +84.00 +83.00						Ų	U			
+81.00 +80.00										

ā	92.345		A1	92.515	91.525	90.930	89.330	87.055	86.450	, vi	86.555	A2	88.285
5	99.545	96.680		94.015	92.725	93.430	93.830	94.255	94.250	95.390	97.355	000	100.085
12.00	-50.000			8	-20.000	-10.000	0000	10.000	20.000		35.000	39.000	45.000

ELEVATION



KERALA IRRIGATION INFRASTRUCTURE **DEVELOPMENT CORPORATION LIMITED**

CONSTRUCTION OF REGULATOR CUM BRIDGE ACROSS KUPPAM RIVER AT KOOVERI KATTAMPALLY IN KANNUR DIST-(REVISED MFL)

SCALE: 1:100 DRAWN BY: DESIGNED BY: CHECKED BY: APPROVED BY: DRAWING NO. KIIDC/271/KIIFB-RCB/2017 GENERAL DRAWING

SHEET NO.: 1 OF 8


NOTES

1. Refer drawing 1 of 8 to 8 of 8.

DATE: 19.10.2020

SHEET NO.: ADDITIONAL SHEET 2

PLAN

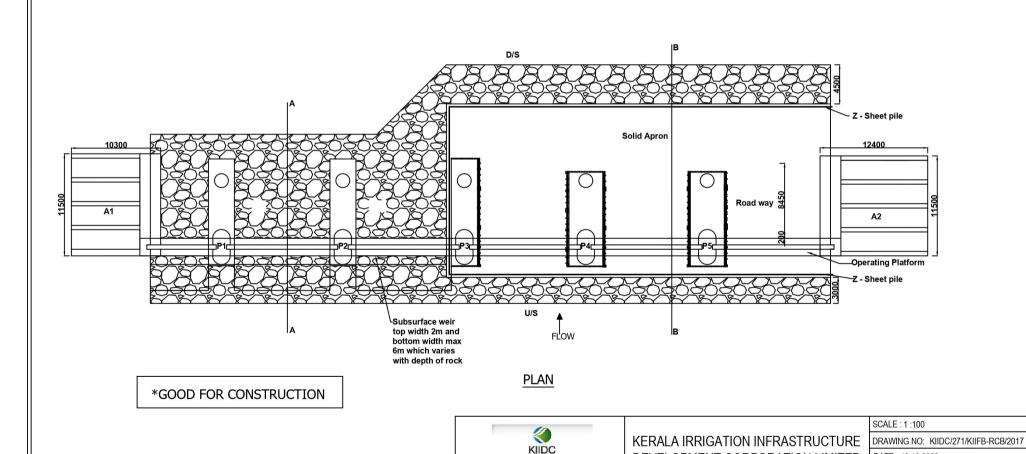

KERALA IRRIGATION INFRASTRUCTURE DEVELOPMENT CORPORATION

CHIEF ENGINEER

DEVELOPMENT CORPORATION LIMITED

CONSTRUCTION OF REGULATOR CUM BRIDGE ACROSS KUPPAM RIVER AT

KOOVERI KATTAMPALLY IN KANNUR DIST-(REVISED MFL)